

2021 HMA OVERLAY PROJECT OLD HIGHWAY 99

ESHMA21-1

VICINITY MAP

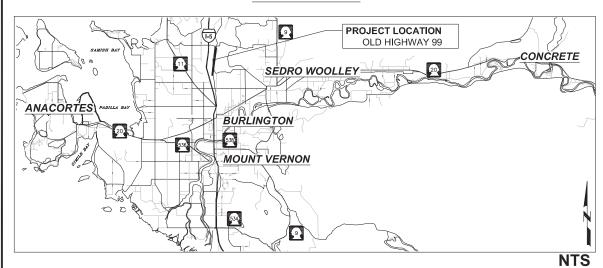

OLD HIGHWAY 99 SITE MAP

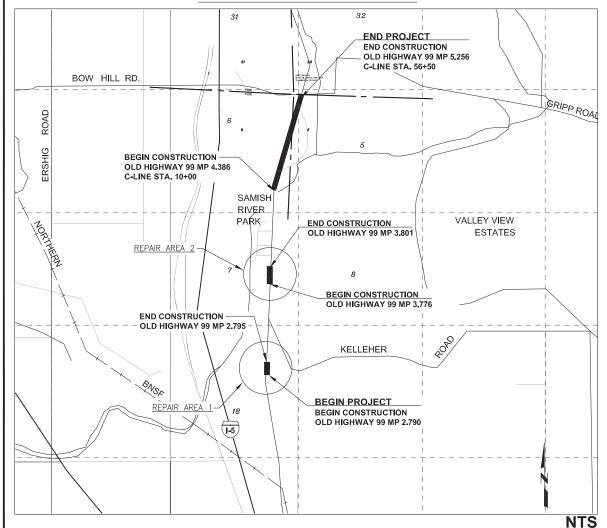



SKAGIT COUNTY OFFICIALS

BOARD OF COMMISSIONERS

·LISA JANICKI, CHAIR

•PETER BROWNING, COMMISSIONER


•RON WESEN, COMMISSIONER

PUBLIC WORKS


•DAN BERENTSON, DIRECTOR



Sheet List Table					
Sheet Number	Sheet Title				
1	COVER SHEET				
2	LEGEND, ABBREVIATIONS AND NOTES				
3	SITE PLAN				
4	SITE PLAN				
5	PAVING DETAILS				
6	PAVING DETAILS				
7	CLASS A SIGNING PLAN				

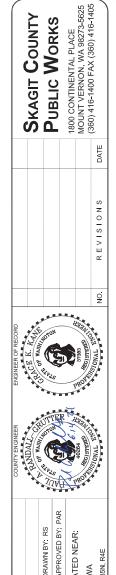



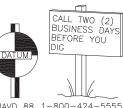

2021 HMA OVERLAY

1 INCH SCALE BAR ADJUST SCALE ACCORDINGLY

SHEET 1 OF 6

tem No.	Spec.	Qty.	Unit	Item Description
				PREPARATION
1	1-09.7	1	LS	MOBILIZATION
				GRADING
2	2-03.5	610	CY	ROADWAY EXCAVATION INCL. HAUL
3	2-03.5	422	CY	EMBANKMENT COMPACTION
				SURFACING
4	8-15.5	299	TON	
5	4-04.5	95	TON	
6	4-04.5	308	TON	
7	4-04.5	140	TON	CRUSHED SURFACING TOP COURSE
				HOT MIX ASPHALT
8	5-04.5	18,660	SY	PLANING BITUMINOUS PAVEMENT
9	5-04.5	260	TON	HMA FOR PAVEMENT REPAIR CL. 1/2" PG 58H-22
10	5-04.5	2,320	TON	HMA CL. 1/2" PG 58H-22
11	5-04.5	130	TON	HMA FOR APPROACH CL. 1/2 IN. PG 58H-22
				EDOCION CONTROL AND DI ANTINO
12	8-01.5	12	DAY	EROSION CONTROL AND PLANTING ESC LEAD
13	8-01.5	1	EST	FORCE ACCOUNT EROSION/WATER POLLUTION CONTROL
10	0-01.0			TORGE AGGOOM ERGORNATERY GEED HON GONTROE
				TRAFFIC
14	8-22.5	376	LF	PLASTIC LINE
15	8-22.5	46	LF	PLASTIC STOP LINE
16	8-23.5	27,900	LF	TEMPORARY PAVEMENT MARKING - SHORT DURATION
17	1-10.5	1	LS	PROJECT TEMPORARY TRAFFIC CONTROL
				OTHER ITEMS
18	1-05.4 SP	1	LS	ROADWAY SURVEYING
19	2-11.5	1	LS	TRIMMING AND CLEANUP
20	2-12.5	740	SY	CONSTRUCTION GEOTEXTILE FOR SEPARATION
21	2-12.5	740	SY	CONSTRUCTION GEOTEXTILE FOR SOIL STABILIZATION
22	1-07.15	1	LS	SPCC PLAN
23	1-05.4 SP	1	EST	FORCE ACCOUNT LICENSED SURVEYING
24	1-09.6 SP	1	EST	UNANTICIPATED UNSUITABLE SUBGRADE REPAIR
25	1-09.6 SP	1	EST	UNANTICIPATED UNDERGROUND CONFLICTS
26	1-09.6 SP	1	EST	UNANTICIPATED MINOR STRUCTURE REVISIONS
27	1-09.6 SP	1	EST	UNANTICIPATED DEWATERING
28	1-09.6 SP	1	EST	UNANTICIPATED REPAIR/RESTORATION OF PUBLIC AND PRIVATE FACILITIES

EXISTING		PROPOSED	
	EDGE OF ASPHALT		CONSTRUCTION CENTERLINE
	SHOULDER		SKIP STRIPE CENTERLINE
——————————————————————————————————————	BURIED OPTIC FIBER LINE		EDGE LINE
———— BP ————	BURIED POWER LINE		DOUBLE YELLOW CENTERLINE
———— BM ————	BURIED MULTIPLE UTILITIES LINE		WIDE LANE LINE
——— BT ————	BURIED TELEPHONE LINE		STOP LINE
— w — — w — —	BURIED WATER LINE	I	
	RAILROAD CENTER LINE		PROPOSED SIGN
	CITY/COUNTY BOUNDARY LINE		
0 0	EXIST. GUARDRAIL		
	DOUBLE YELLOW CENTERLINE DOTTED LINE		
	BRIDGE		
	EXIST. TRAFFIC LOOP		
	CATCH BASIN		
\oplus	SURVEY MONUMENT		
\boxplus	WATER METER		
\bowtie	WATER VALVE		
← > <	RAILROAD SIGNAL		
→	EXIST. SIGN		
\circ	MANHOLE		
\odot	POWER POLE		
\leftarrow	DOWN GUY WIRE		


GENERAL NOTES


- ALL WORK SHALL BE PERFORMED IN ACCORDANCE WITH THE CONTRACT PLANS AND PROVISIONS, STANDARD SPECIFICATIONS, MANUAL ON UNIFORM TRAFFIC CONTROL DEVICES (MUTCD), AND THE 2021 WSDOT STANDARD SPECIFICATIONS FOR ROAD, BRIDGE, AND MUNICIPAL CONSTRUCTION.
- 2. ALL UTILITIES SHOWN ARE APPROXIMATE. CONTRACTOR SHALL VERIFY THE LOCATION OF ALL UNDERGROUND UTILITIES BEFORE DIGGING. CALL 1-800-424-5555 AT LEAST TWO (2) BUSINESS DAYS BEFORE YOU DIG.
- 3. THE DEBRIS MATERIAL RESULTING FROM THE PLANING OPERATIONS WILL BECOME THE PROPERTY OF SKAGIT COUNTY PUBLIC WORKS AND DISPOSED OF IN A COUNTY-PROVIDED SITE. DETAILS OF THIS WORK CAN BE FOUND IN THE PLAN'S SPECIAL PROVISIONS SECTION AS SKAGIT COUNTY SPECIFICATION 5-04.3(14) "PLANING BITUMINOUS PAVEMENT".
- 4. THE CONTRACTOR IS EXPECTED TO PREVENT EROSION AND THE RELEASE OF SEDIMENT AND OTHER POLLUTANTS THROUGH BEST MANAGEMENT PRACTICES (BMPS). THE GOAL IS TO KEEP POLLUTANTS OUT OF STORM DRAINS, WATERWAYS AND ADJACENT PROPERTIES.


ABBREVIATIONS:


AP	ANGLE POINT	IN & "	INCHES
ASPH	ASPHALT	K	CURVE COEFFICIENT
AVE			LENGTH OF CURVE
BLDG	BUILDING	LF	LINEAR FOOT
BVC		LS	LUMP SUM
CALC	CALCULATED	LT	LEFT
CB	CATCH BASIN	MAX	MAXIMUM
CL & Q		MIN	MINIMUM
CP	CONTROL POINT	MIC	MONUMENT IN CASE
CPCP	CORRUGATED POLYETHYLENE	MON	MONUMENT
		MUTCD	
CONT'D	CONTINUED		CONTROL DEVICES
CSBC	CRUSHED SURFACING BASE COURSE	N	NORTH/NORTHING
	CULVERT	NTS	NOT TO SCALE
CY	CUBIC YARD	PC	POINT OF CURVATURE
DEG	DEGREE	PI	POINT OF INTERSECTION
DIA	DIAMETER	PT	POINT OF TANGENCY
E	EAST/EASTING	R	RADIUS
EL & ELEV	ELEVATION	RD	ROAD
EST		RGE	RANGE
	END VERTICAL CURVE	R/W & ROW	RIGHT OF WAY
FT & '	FEET	RT	RIGHT
GALV	GALVANIZED	S	SOUTH
	GROUND	SEC	SECTION
	HOT MIX ASPHALT	SF	SQUARE FOOT
HR	HOUR	SHLD	SHOULDER

SPEC ST STA SY SYM TWN TYP UG VCL VPI W W.M. WSDOT	SPECIFICATIONS STREET STATION SQUARE YARD SYMMETRICAL TOWNSHIP TYPICAL UNDERGROUND VERTICAL CURVE LENGTH VERTICAL POINT INTERSECTION WEST WILLAMETTE MERIDIAN WASHINGTON STATE DEPARTMENT OF TRANSPORTATION

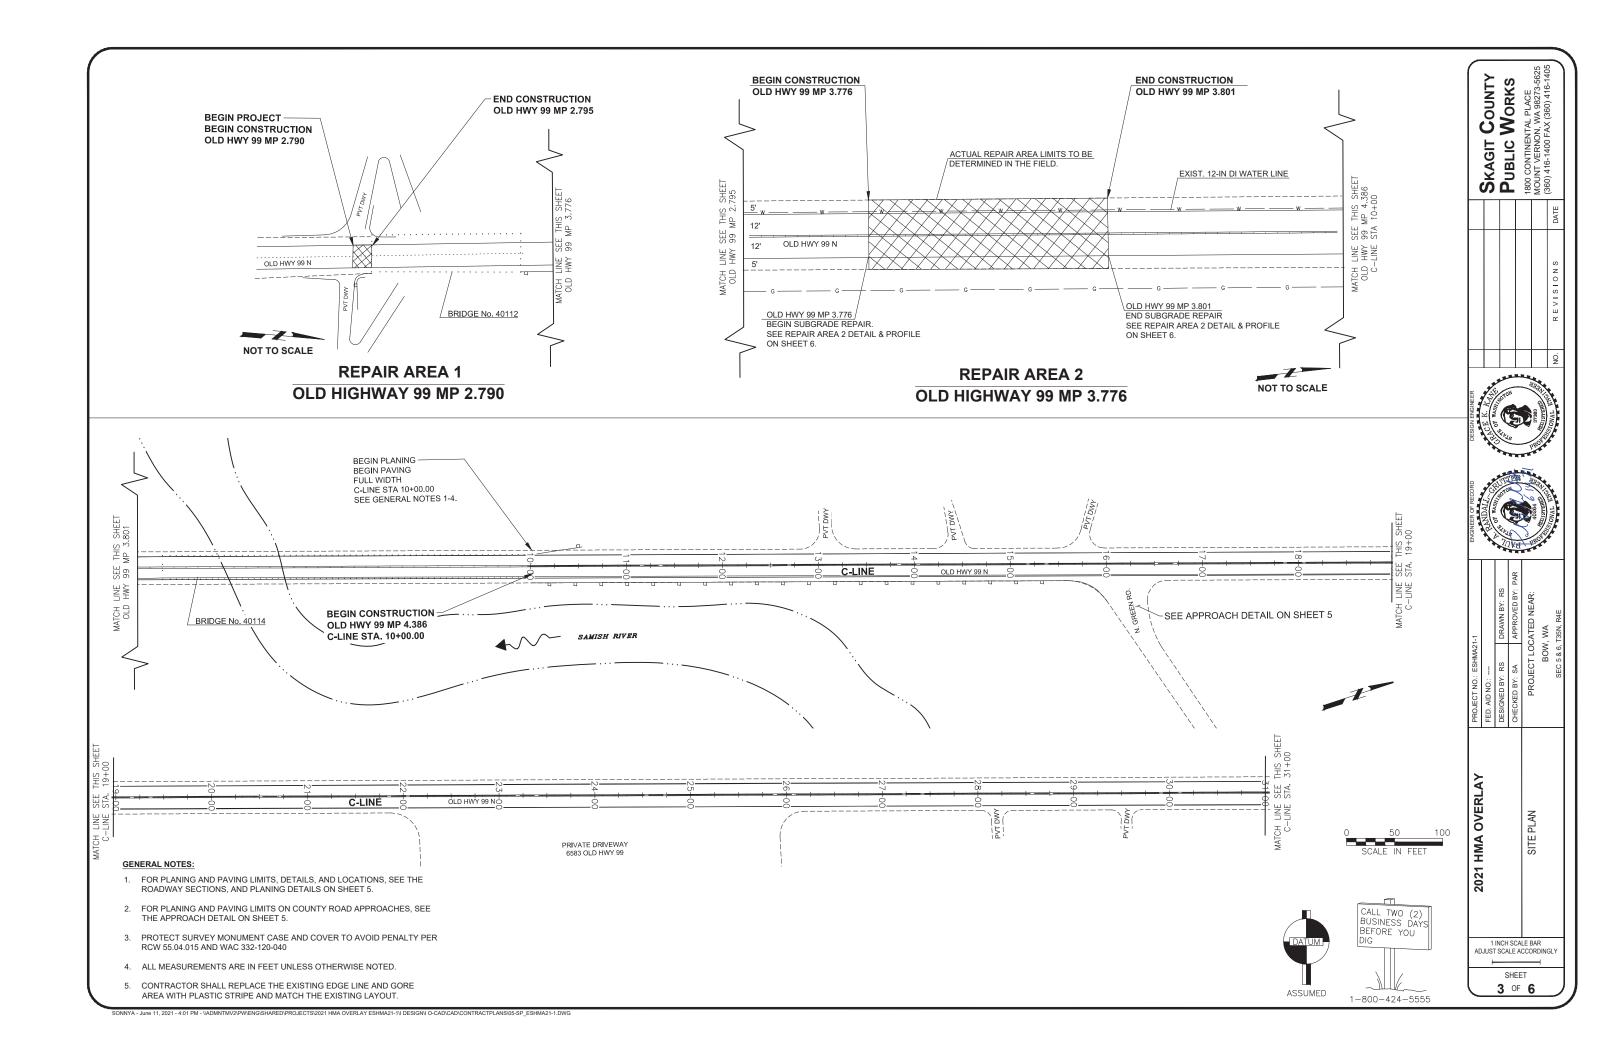

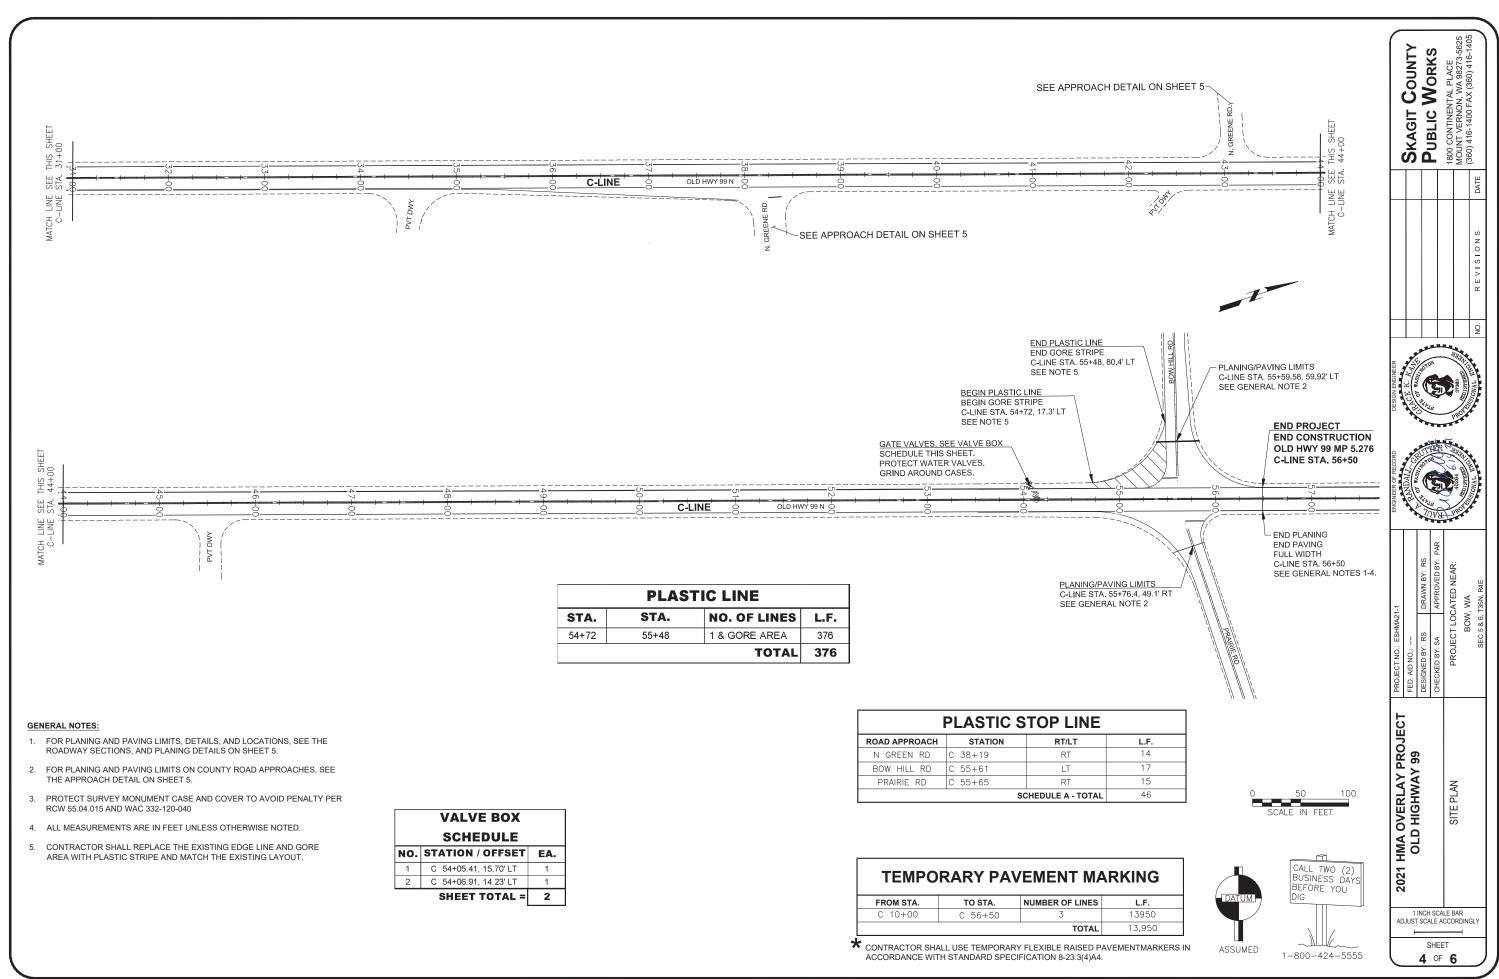

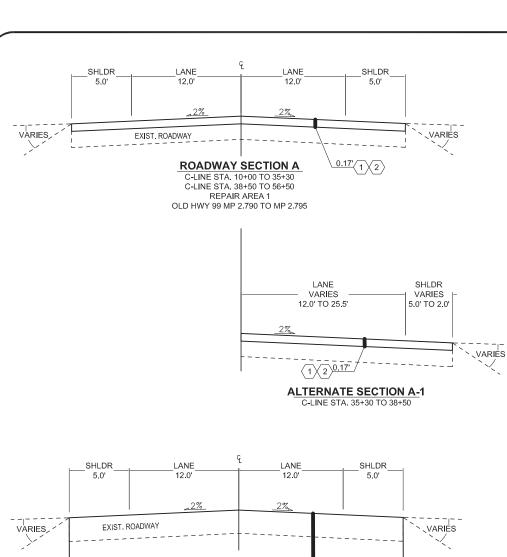

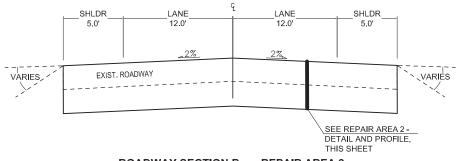


ROADWAY SECTION B - REPAIR AREA 2 APPROXIMATE MP 3.776 TO MP 3.801

ROADWAY SECTIONS

NEW PAVEMENT JOINT. BEGIN PLANING AND PAVING, SEE ROADWAY SECTIONS. FINAL HMA LIFT TO BE FLUSH WITH BUTT JOINT. SEAL WITH HOT POURED JOINT SEAL. TOP OF ROADWAY -EXIST. ROADWAY 0.17'(1)(2)

BUTT JOINT DETAIL Scale: NTS

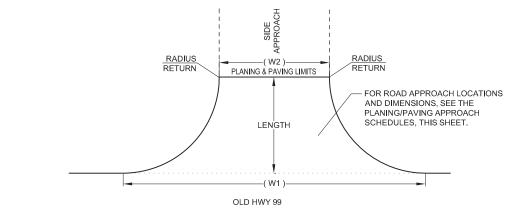

APPROACH DETAIL

Scale: NTS

Scale: NTS

PLANING/PAVING APPROACH SCHEDULE									
ROAD	STA	TION	LT/RT	W1 [*]	W2*	LENGTH*	DEPTH	S.Y.	TONS
N. GREEN RD.	С	16+21	RT	101	40	25	0.17	161	20.0
N. GREEN RD.	С	38+19	RT	83	34	25	0.17	133	16.0
N. GREEN RD.	С	43+08	LT	72	24	25	0.17	103	12.0
BOW HILL RD.	С	55+61	LT	172	71	25	0.17	303	36.0
PRAIRIE RD.	С	55+65	RT	130	34	34	0.17	284	34.0
* DIMENSIONS ARE ARROWNANTE CONTRACTOR TO FIELD EIT AT THE							Total =	207 S V	130 Tone

ONS ARE APPROXIMATE. CONTRACTOR TO FIELD FIT AT THE DIRECTION OF THE ENGINEER.

Total = 397 S.Y. | 130 Tons

LEGEND:

- 1 PLANING BITUMINUS PAVEMENT
- (2) HMA CL 1/2 IN. PG 58H-22
- 3 HMA FOR PAVEMENT REPAIR CL.1/2 IN. PG 58H-22
- 4 CRUSHED SURFACING TOP COURSE (CSTC)
- $\left\langle 5\right\rangle$ CRUSHED SURFACING BASE COURSE (CSBC)
- 6 QUARRY SPALLS
- $\langle 7 \rangle$ BALLAST
- $\langle 8 \rangle$ PAVEMENT REPAIR EXCAVATION INCL. HAUL


GENERAL NOTES:

- 1. ALL DIMENSIONS SHOWN IN PLANS ARE IN FEET UNLESS OTHERWISE NOTED.
- 2. ALL DEPTHS SHOWN ARE COMPACTED DEPTHS.
- 3. EMBANKMENT COMPACTION SHALL BE CALCULATED BY THE QUANTITY OF CSTC, CSBC, QUARRY SPALLS, AND BALLAST PLACED PER DETAIL 4.

CONSTRUCTION NOTES:


FINAL LIFT TO BE PLACED AS WEARING


CONTRACTOR SHALL EXCAVATE TO SUITABLE SUBGRADE, AS DETERMINED BY THE ENGINEER.

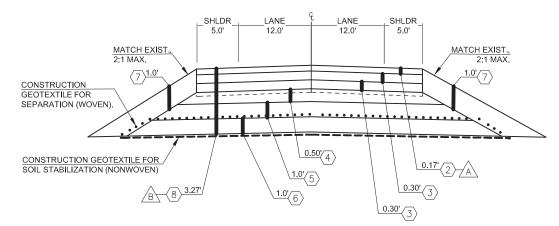


(4) REPAIR AREA 2 - DETAIL

Scale: NTS

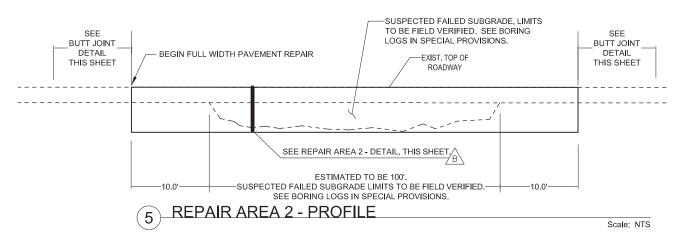

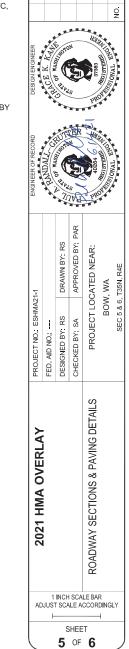

SKAGIT COUNTY PUBLIC WORKS

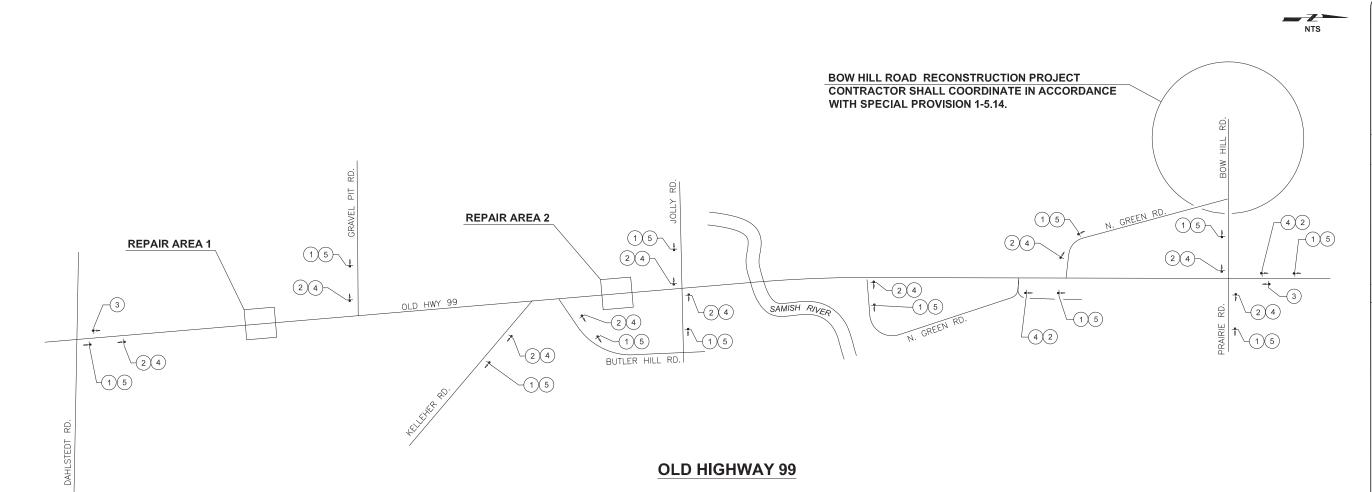

LEADER NO.	CONSTRUCTION SIGN	QUAI	YTITY	SIZE	(S.F.)
1	ROAD WORK AHEAD W20-1	1:	2	48"x48"	192
2*	MOTORCYCLES USE EXTREME CAUTION W21-1701P	12		36"x18"	54
3	END OF ROAD WORK	2		48"x24"	16
4*	GROOVED W20-1	12		48"x48"	192
5	OLD HWY 99 G20-2 (MOD1)	1:	2	48"x24"	96
*COVER SIGI	NS UNLESS CONDITION EXIS	STS	TOTA	AL S.F. =	550

CONSTRUCTION SIGN CLASS A NOTES:

- 1. SIGNS SHALL BE PLACED IN ACCORDANCE WITH THE MOST CURRENT M.U.T.C.D. ADOPTED BY WAC 468-95 AND IT'S MODIFICATIONS.
 2. SIGNS SHALL CONFORM TO THE 2021 WSDOT STANDARD SPECIFICATIONS FOR ROAD, BRIDGE, AND MUNICIPAL CONSTRUCTION.
- BRIDGE, AND MUNICIPAL CONSTRUCTION.

 3. SIGNS SHALL NOT BE LOCATED WHERE THEY MAY CAUSE SIGHT DISTANCE PROBLEMS.

 4. IF WORK INCLUDES GROOVED PAVEMENT, ABRUPT LANE EDGES, STEEL PLATES, OR GRAVEL OR EARTH SURFACES, SIGNS SHALL BE PLACED STATING THE CONDITION, AS REQUIRED BY THE CURRENT M.U.T.C.D. & WAC 468-95.

 5. CONTRACTOR SHALL FURNISH ALL SIGNS.

 6. SIGNS SHALL BE MOUNTED ON 4X4 POSTS.

 7. CLASS B SIGNS ARE NOT SHOWN ON DRAWING.

 8. ALL SIGN SPACING MAY BE ADJUSTED TO ACCOMMODATE AT-GRADE INTERSECTIONS AND DRIVEWAYS.

